

SEA 90-S-021 2232-Y13-10 NOVEC - JOHNSON SUBSTATION 15001 LEE HWY CENTREVILLE, VA 20121

GENERAL NOTES

Verizon wireless

- THE CONTRACTOR SHALL GIVE ALL NOTICES AND COMPLY WITH ALL LAWS, ORDINANCES, RULES, REGULATIONS AND LAWFUL ORDERS
 OF ANY PUBLIC AUTHORITY, MUNICIPAL AND UTILITY COMPANY SPECIFICATIONS, AND LOCAL AND STATE JURISDICTIONAL CODES BEARING
 ON THE PERFORMANCE OF THE WORK. THE WORK PERFORMED ON THE PROJECT AND THE MATERIALS INSTALLED
 SHALL BE IN STRICT ACCORDANCE WITH ALL APPLICABLE CODES, REGULATIONS AND ORDINANCES.
- 2. THE ARCHITECT/ENGINEER HAS MADE EVERY EFFORT TO SET FORTH IN THE CONSTRUCTION AND CONTRACT DOCUMENTS THE COMPLETE SCOPE OF WORK. THE CONTRACTOR BIDDING THE JOB IS NEVERTHELESS CAUTIONED THAT MINOR OMISSIONS OR ERRORS IN THE DRAWINGS AND OR SPECIFICATIONS SHALL NOT EXCUSE SAID CONTRACTOR FROM COMPLETING THE PROJECT AND IMPROVEMENTS IN ACCORDANCE WITH THE INTENT OF THESE DOCUMENTS.
- 3. THE CONTRACTOR OR BIDDER SHALL BEAR THE RESPONSIBILITY OF NOTIFYING (IN WRITING) THE CONSTRUCTION MANAGER OF ANY CONFLICTS, ERRORS, OR OMISSIONS PRIOR TO THE SUBMISSION OF CONTRACTOR'S PROPOSAL OR PERFORMANCE OF WORK. IN THE EVENT OF DISCREPANCIES THE CONTRACTOR SHALL PRICE THE MORE COSTLY OR EXTENSIVE WORK, IN THE PRICE THE MORE COSTLY OR EXTENSIVE WORK,
- 4. THE SCOPE OF WORK SHALL INCLUDE FURNISHING ALL MATERIALS, EQUIPMENT, LABOR AND ALL OTHER MATERIALS AND LABOR DEFINED NECESSARY TO COMPLETE THE WORK/PROJECT AS DESCRIBED HEREIN.
- 5. THE CONTRACTOR SHALL VISIT THE JOB SITE PRIOR TO THE SUBMISSION OF BIDS OR PERFORMING WORK TO FAMILIARIZE HIMSELF WITH THE FIELD CONDITIONS AND TO VERIFY THAT THE PROJECT CAN BE CONSTRUCTED IN ACCORDANCE WITH THE CONTRACT DOCUMENTS.
- 6. THE CONTRACTOR SHALL OBTAIN AUTHORIZATION TO PROCEED WITH CONSTRUCTION PRIOR TO STARTING WORK ON ANY ITEM NOT CLEARLY DEFINED BY THE CONSTRUCTION DRAWING/CONTRACT DOCUMENTS.
- THE CONTRACTOR SHALL INSTALL ALL EQUIPMENT AND MATERIALS ACCORDING TO THE MANUFACTURER'S/VENDOR'S SPECIFICATION
 UNLESS NOTED OTHERWISE OR WHERE LOCAL CODES OR ORDINANCES TAKE PRECEDENCE.
- 8. THE CONTRACTOR SHALL PROVIDE A FULL SET OF CONSTRUCTION DOCUMENTS AT THE SITE UPDATED WITH THE LATEST REVISIONS AND ADDENDA OR CLARIFICATIONS AVAILABLE FOR THE USE BY ALL PERSONNEL INVOLVED WITH THE PROJECT.
- THE CONTRACTOR SHALL SUPERVISE AND DIRECT THE PROJECT DESCRIBED HEREIN. THE CONTRACTOR SHALL BE SOLELY
 RESPONSIBLE FOR ALL CONSTRUCTION MEANS, METHODS, TECHNIQUES, SEQUENCES AND PROCEDURES AND FOR COORDINATING
 ALL PORTIONS OF THE WORK UNDER THE CONTRACT.
- 10. THE CONTRACTOR SHALL BE RESPONSIBLE FOR OBTAINING ALL PERMITS AND INSPECTIONS WHICH MAY BE REQUIRED FOR THE BY THE ARCHITECT/ENGINEER, THE STATE, COUNTY OR LOCAL GOVERNMENT AUTHORITY.
- 11. THE CONTRACTOR SHALL MAKE NECESSARY PROVISIONS TO PROTECT EXISTING IMPROVEMENTS, EASEMENTS, PAVING, CURBING, ETC. DURING CONSTRUCTION. UPON COMPLETION OF WORK, THE CONTRACTOR SHALL REPAIR ANY DAMAGE THAT MAY HAVE OCCURRED DUE TO CONSTRUCTION ON OR ABOUT THE PROPERTY.
- 12. THE CONTRACTOR SHALL KEEP THE GENERAL WORK AREA CLEAN AND HAZARD FREE DURING CONSTRUCTION AND DISPOSE OF ALL DIRT, DEBRIS, RUBBISH AND REMOVE EQUIPMENT NOT SPECIFIED AS REMAINING ON THE PROPERTY. PREMISES SHALL BE LEFT IN CLEAN CONDITION AND FREE FROM PAINT SPOTS, DUST, OR SMUDGES OF ANY NATURE.
- 13. THE CONTRACTOR SHALL COMPLY WITH ALL OSHA REQUIREMENTS AS THEY APPLY TO THIS PROJECT
- 14. THE CONTRACTOR SHALL NOTIFY THE CONSTRUCTION MANAGER WHERE A CONFLICT OCCURS ON ANY OF THE CONTRACT DOCUMENTS.
 THE CONTRACTOR IS NOT TO ORDER MATERIAL OR CONSTRUCT ANY PORTION OF THE WORK THAT IS IN CONFLICT UNTIL
 THE CONFLICT IS RESOLVED BY THE CONSTRUCTION MANAGER.
- 15. THE CONTRACTOR SHALL VERIFY ALL DIMENSIONS, ELEVATIONS, PROPERTY LINES, ETC. ON THE PROJECT.

MILESTONE COMMUNICATIONS: NOVEC REPRESENTATIVE: NAME DATE DATE

VICINITY MAP

FROM 1-495 (CAPITAL BELTWAY), TAKE EXIT 49 ON THE RIGHT FOR INTERSTATE 66 W TOWARD VIENNA/ FRONT ROYAL, MERGE ONTO 1-66 W, TAKE EXIT 52 FOR US-29 TOWARD CENTREVILLE, TURN RIGHT ONTO US-29 S/ LEE HWY, PROCEED 0.9 MILES TO 15001 LEE HWY CENTREVILLE, VA 20121.



SYMBOLS AND ABBREVIATIONS

DJ	ADJUSTABLE	MECH	MECHANICAL	+	SPOT ELEVATION
PPROX	APPROXIMATE	MFR	MANUFACTURER		
AB	CABINET	MGB	MAIN GROUND BAR	ę	CENTERLINE
_G	CEILING	MIN	MINIMUM	Ł	CENTEREINE
ONC	CONCRETE	MTL	METAL	P	PLATE
TNC	CONTINUOUS	NIC	NOT IN CONTRACT	"L	TEATE
J	CONSTRUCTION JOINT	NTS	NOT TO SCALE		
Α	DIAMETER	OC	ON CENTER	No.	DETAIL NUMBER
WG	DRAWING	OPP	OPPOSITE	\SHT \	SHEET NUMBER
3B	EQUIPMENT GROUND BAR	SF	SQUARE FOOT	$\overline{}$	
4	EACH	SHT	SHEET	—	- GROUND WIRE
.EC	ELECTRICAL	SIM	SIMILAR		- GROUND WIKE
_	ELEVATION	SS	STAINLESS STEEL	0	
2	EQUAL	STL	STEEL		ANTENNA
QUIP	EQUIPMENT	TOC	TOP OF CONCRETE		0.411
KT	EXTERIOR	TOM	TOP OF MASONRY		<u>CALL</u>
-	FINISHED FLOOR	TOS	TOP OF STEEL	U	TILITIES NOTIFICATION
Ą	GAGE	TYP	TYPICAL		MISS UTILITY
ALV	GALVANIZED	VIF	VERIFY IN FIELD		1-800-552-7001
3	GROUND BAR	UON	UNLESS OTHERWISE NOTED		NG DAYS PRIOR TO DIGGING
0	GENERAL CONTRACTOR	WWF	WELDED WIRE FABRIC		JTIONS SHALL BE IMPLEMENTED BY
RND	GROUND	W/	WITH	CONTRACTOR(S) AT ALL TRENCHING IN ACCORDANCE WITH CURRENT OSHA STANDARD
3	LONG	&	AND		COUNTRY COUNTY STANDARD
Н	LONG LEG HORIZONTAL	0	AT		

MAXIMUM

SHEET INDEX

- T-1 TITLE SHEET

 Z-1 SPECIAL EXCEPTION PLAT
- Z-2 EROSION AND SEDIMENT CONTROL PLAN AND DETAILS
- Z-3 COMPOUND PLAN
- **Z-4** TOWER ELEVATION
- Z-5 SITE PROFILES
- Z-6 CIVIL MAPS
- **Z-7** SITE DETAILS
- Z-8 ANTENNA SCHEDULE AND DETAILS
- Z-9 RRH AND DISTRIBUTION BOX DETAILS
- Z-10 SHELTER PLANS AND GENERATOR DETAILS
- 2-11 SHELTER ELEVATIONS
- Z-12 LANDSCAPE PLAN, DETAILS AND NOTES
- Z-13 TREE CANOPY CALCULATION
- Z-14 DRAINAGE AREA MAP AND CALCULATIONS
- **Z-15 BMP CALCULATIONS**


11-07-13 COUNTY COMMENTS 02-19-14 COUNTY COMMENTS 06-24-14 COUNTY COMMENTS 08-08-14 COUNTY COMMENTS

05-28-13 ZONING REVIEW

6600 Rockledge Drive, Suite 550 BETHESDA, MD 20817 PHONE: (202)408-0960 FAX: (202)408-0961

SUBMITTALS

DESCRIPTION

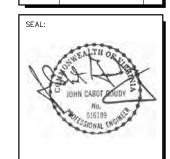



PROJECT NO:	1050.130
DESIGNER:	M.A.
ENGINEER:	M.M.
SCALE:	
0 1/2	
GRAPHIC	SCALE IN INCHES

SEA 90-S-021 2232-Y13-10 NOVEC - JOHNSON SUBSTATION 15001 LEE HWY

CENTREVILLE. VA 20121

TITI F

TITLE SHEET

SHEET NUMBER:

T-1

PROJECT DESCRIPTION

SCOPE OF WORK: 1. INSTALL A NEW 130'-0" HIGH SELF SUPPORT TOWER FOUNDATIONS AND TOWER.
2. INSTALL GRUNDING, UTILITIES, COMPOUND SUBGRADE AND FENCING.

- INSTALL LANDSCAPING.
 INSTALL VERIZON WIRELESS EQUIPMENT SHELTER AND GENERATOR FOUNDATIONS.
- INSTALL VERIZON WIRELESS EQUIPMENT SHELTER AND GENERATOR.

 S. INSTALL VERIZON WIRELESS SHELTER AND GENERATOR.
- 6. INSTALL VERIZON WIRELESS PANEL ANTENNAS ON A STANDOFF FRAMES ON THE TOWER.
- 7. INSTALL VERIZON WIRELESS PAINEL ANTENNAS ON A STANDOFF FRAMES ON THE TOWE

PROPERTY OWNER: ELECTRIC COOPERATIVE, PRINCE WILLIAM 10323 LOMOND DR. MANASSAS, VA 20109

ANT: MILESTONE COMMUNICATIONS
12110 SUNSET HILLS ROAD, SUITE 100
RESTON, VA 20107
MR. LEN FORKAS
(703) 620-2555 EX. 104

SUITE 100

JURISDICTION:
PROPERTY INFO:
CURRENT ZONING:
USE:

GROUND ELEVATION:

LATITUDE:

LONGITUDE:


FAIRFAX COUNTY
MAP #: 0642 03 0026A
RC
ELECTRIC UTILITIES /

TELECOMMUNICATIONS SITE

N 38° 49' 53,972'

249.35' AMSL

_

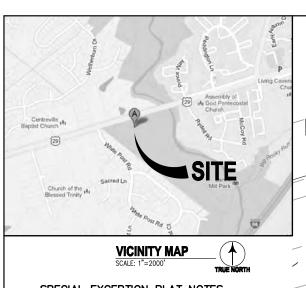


SPECIAL EXCEPTION PLAT NOTES

- 1.) SITE NAME: NOVEC JOHNSON SUBSTATION
- THIS IS NOT A BOUNDARY SURVEY AND IS NOT TO BE USED FOR THE TRANSFER OF PROPERTY.
- THE SUBJECT PARCEL INFORMATION; OWNER: ELECTRIC COOPERATIVE, PRINCE WILLIAM MAILING ADDRESS: 10323 LOMOND DRIVE MANASSAS, VA 20109
 PROPERTY ADDRESS: 15001 LEE HWY
 CENTREVILLE, VA 20121 COUNTY: FAIRFAX COUNTY PARCEL ID #: 0642 03 0026A
 TAX DISTRICT : 90200 DULLY DISTR 2
 DEED BK: 02955 PG: 0640 LAND AREA: 2.7584 AC USE: ELECTRIC UTILITIES
- OVERLAY DISTRICT: WATER SUPPLY PROTECTION (WS) 4.) THE DATUM'S ARE NAD 83 AND NAVD 88, AND THE BEARING BASE IS STATE GRID.
- 5.) NO UNDERGROUND UTILITIES HAVE BEEN
- LOCATED, THE PRESENCE OF ANY SUCH UTILITIES MUST BE CONFIRMED BY THE CONTRACTOR BEFORE CONSTRUCTION 6.) NO WETLANDS HAVE BEEN DEFINED AND ANY AREAS SHOWN AS MARSH, PONDS OR
- DITCHES ARE DONE SO FROM VISIBLE SURFACE FEATURES AND IN NO WAY CONSTITUTE A DEFINED WETLAND.
- AS FOLLOWS: FLOOD ZONE X. AREAS DETERMINED TO BE OUTSIDE THE 0.2% ANNUAL CHANCES FLOODPLAIN. SOURCE, FEMA FLOOD MAP FOR FAIRFAX COUNTY, VA. COMMUNITY PANEL NUMBER 51059C 0230E. EFFECTIVE, SEPTEMBER 17, 2010.
- 8.) TITLE REPORT WAS FURNISHED FOR THIS SURVEY WAS FURNISHED BY HITECH TITLE SOLUTIONS, INC., FILE# 15001 LEE.
- 9.) THE DATA COLLECTED AND SHOWN ON THIS DRAWING ARE FOR THE PURPOSES OF CONSTRUCTION OF A CELLULAR TOWER, ANY NECESSARY ANCILLARY EQUIPMENT AND ALL APPROPRIATE EASEMENTS.
- 10.) NO UNRECORDED EASEMENTS ARE SHOWN ON THIS SURVEY AND IT IS POSSIBLE THAT SUCH EASEMENTS IMPACT THE SITE.
- 11.) THIS PROPERTY IS SUBJECT TO ALL MATTERS OF PUBLIC RECORD.
- 12.) THE LOCATION OF THE PROPOSED TOWER IS AS FOLLOWS: THE VALUES LISTED BELOW ARE WITHIN ±50' HORIZONTAL AND ±20' VERTICAL. LATITUDE: N 38* 49' 53.972" LONGITUDE: W 77* 27' 55.996"

ELEVATION: 249.35' AMSL AT BASE

13.) THE EXISTING TOPOGRAPHY IS TAKEN FROM A FIELD RUN SURVEY WITH A MAXIMUM TWO FOOT CONTOUR INTERVAL PREPARED BY ENTREX COMMUNICATION

TOWER SETBACKS			
ZONING PBD	REQUIRED	PROPOSED	
FRONT YARD (NORTH)	40'	306.8'	
REAR YARD (N/A)	25'	N/A	
SIDE YARD (SOUTH WEST)	20'	70.7'	
SIDE YARD (EAST)	20'	78.7'	
CLOSEST OFF SITE BUILDING	N/A	326.2'	
CLOSEST ROAD	N/A	345.9'	

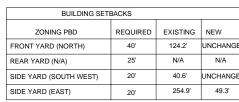

BUILDING INFORMATION

EXISTING ORIGINAL BUILDING: ±8'

MAXIMUM FLOOR AREA RATIO 0.10

TOTAL FLOOR AREA RATIO 0.011

TOTAL PROPOSED GROSS TELECOMMUNICATION

SHELTERS AND PAD FLOOR AREA:

TOTAL EXISTING GROSS BUILDING FLOOR AREA: +/- 240 SF

MAXIMUM BUILDING HEIGHT: 60'

TOTAL FLOOR AREA:

	PARKING SETBACKS			
	ZONING PBD	EXISTING	NEW	
ED	FRONT YARD (NORTH)	105.1'	UNCHANGED	
	REAR YARD (N/A)	N/A	N/A	
ED	SIDE YARD (SOUTH WEST)	54.6'	UNCHANGE	
	SIDE YARD (EAST)	289.7'	17.5'	

LEE HIGHWAY (VA-RTE 29-211 - 160' R/W)

EXISTING ISWM

EXISTING

EASEMENT

MAP # 0642 03 0026A

N/F ELECTRIC COOPERATIVE, PRINCE WILLIAM

PARCEL ADDRESS: N/A MAILING ADDRESS: 10323 LOMOND DR MANASSAS VA 20109

DEED BOOK 02955 PAGE 0640

ZONING: RC AREA: 2,7584 (SQ. FT.)

MAP # 0642 04 A

N/F
PARK AUTHORITY FAIRFAX COUNTY,

PARCEL ADDRESS: N/A
MAILING ADDRESS: 12055 GOVERNMENT CENTER PW SUITE 927

FAIRFAX VA 22035 DEED BOOK 05340 PAGE 0680 ZONING: RC

AREA: 22.6232 (SQ. FT.)

+/- 1,102 SF

+/- 1,342 SF

CONSERVATION

DB 8004 PG 1888-

PARKING SETBACKS			
ZONING PBD	EXISTING	NEW	
FRONT YARD (NORTH)	105.1'	UNCHANGED	
REAR YARD (N/A)	N/A	N/A	
SIDE YARD (SOUTH WEST)	54.6'	UNCHANGED	
SIDE YARD (EAST)	289.7'	17.5'	

EXISTING 15' WIDE VEPCO EASEMENT

DB 8348 PG 1293

(POSSIBLY ABANDONED)

NG SELE			
	EXISTING	NEW	
)	105.1'	UNCHANGED	
	N/A	N/A	
EST)	54.6'	UNCHANGED	
	289.7'	17.5'	

NEW	(
UNCHANGED	,
N/A	
UNCHANGED	SPE
17.5'	SCALE

40.5

- FXISTING

PARKING SPACE

EXISTING 12' W

20' L x 8' H CONTROL HOUSE


CONSTRUCTION

NOV. 1992

SUBSTATION

IN GRAVEL

GATE

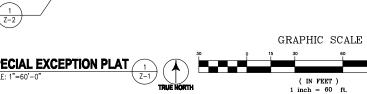

PROPOSED 12

- WIDE GRAVEL ACCESS FOR

INGRESS/EGRESS

EXISTING CONSERVATION

PARKING SPACES	S
	TOTAL
PARKING SPACES PROVIDED	2
PARKING SPACES REQUIRED	N/A

-EXISTING CONSERVATION

MAP # 0642 03 0028

N/F CHI MINAM,

326.2

EASEMENT DB 8004 PG 1888

Π)

PROPOSED TWO

- FIELD ON THE PROPERTY
- FAIRFAX COUNTY, VA. COMMUNITY PANEL
- STONE DUST TRAIL 6' 8' ON THE SOUTH SIDE OF ROLLTE 29 AS SHOWN ON 2/7-6



FAX: (202)408-0961

SUBMITTALS

DESCRIPTION



PROJECT NO:	1050.130	
DESIGNER:	M.A.	
ENGINEER:	M.M.	

SCALE:

GRAPHIC SCALE IN INCHES

SEA 90-S-021 2232-Y13-10 **NOVEC - JOHNSON SUBSTATION 15001 LEE HWY CENTREVILLE, VA 20121**

SPECIAL EXCEPTION PLAT

SHEET NUMBER:

Z-1

6600 Rockledge Drive, Suite 550 BETHESDA, MD 20817 1. THE PROPERTY DOES NOT USE PUBLIC WATER AND OR PUBLIC SEWER. THERE IS NO SEPTIC 2. THE PROPERTY IS IN AREAS DETERMINED TO BE OUTSIDE THE 0.2% ANNUAL CHANCES FLOODPLAIN. SOURCE, FEMA FLOOD MAP FOR NUMBER 51059C 0230E. EFFECTIVE, SEPTEMBER 17, 2010.

3. THERE ARE NO PROPOSED STORM WATER DATE 05-28-13 ZONING REVIEW MANAGEMENT FACILITIES FOR THIS PROJECT.

4. THERE ARE NO GRAVES, OBJECTS OR
STRUCTURES MARKING A PLACE OF BURIAL ON 08-20-13 ZONING 11-07-13 COUNTY COMMENTS THE PROPERTY PER THE FAIRFAX COUNTY CEMETERY MAP. 02-19-14 COUNTY COMMENTS CEMELERT MAP.

5. FAIRFAX COUNTY COMPREHENSIVE PLAN, LAND
USE MAP SECTION 64-2, SHOWS A MINOR PAVED
TRAIL WITH PARALLEL NATURAL SURFACE OR 06-24-14 COUNTY COMMENTS 08-08-14 COUNTY COMMENTS 6. THERE ARE NO PROPOSED SIGNS FOR THIS PROJECT. GRID N: 6987583.634 GRID E: 11777589.127 LATITUDE: 38'49'53.972" LONGITUDE: -77'27'55.996" GROUND ELEVATION: 249.35' AMSL AT BASE CHI MINAM,
PARCEL ADDRESS:
MAILING ADDRESS: 14927 LEE HWY
CENTREVILLE VA 20121
DEED BOOK 22735 PAGE 1453
ZONING: RC **LEGEND** ☆ LIGHT POLE INDIVIDUAL TREE INDIVIDUAL TREE-TO BE REMOVED P EXISTING PARKING SPACE


LINE TYPES BOUNDARY LINE - PARENT PARCEL RIGHT OF WAY/CONSERVATION EASEMENT BOUNDARY


FENCE LINE - CHAIN

1' CONTOUR LINE


5' CONTOUR LINE

TREE OR VEGETATION LINE

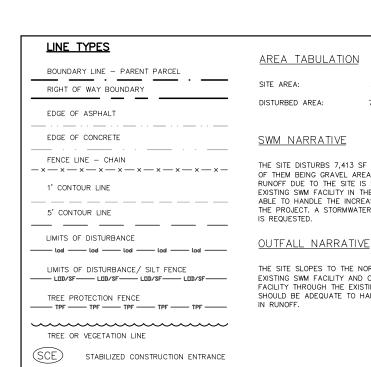

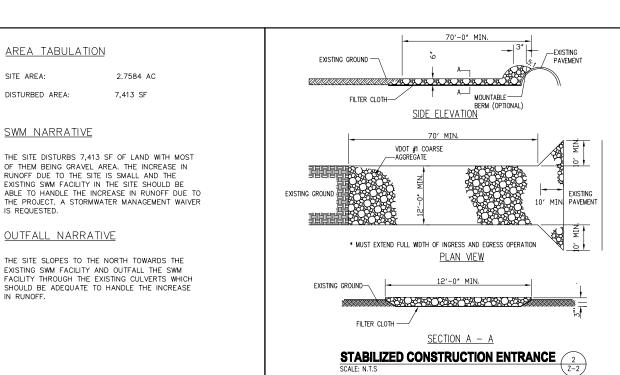

(IN FEET) 1 inch = 40 f

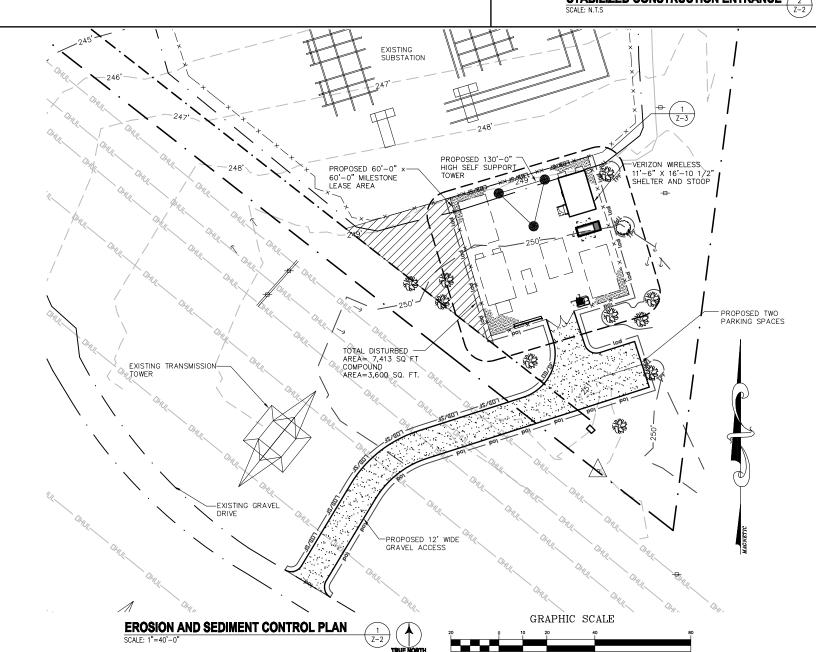


CONSTRUCTION OF A SILT FENCE (WITHOUT WIRE SUPPORT)

1. SET THE STAKES.





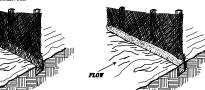





POINTS A SHOULD BE HIGHER THAN POINT B DRAINAGE WAY INSTALLATION (FRONT ELEVATION)



- SILT FENCES SHALL BE INSPECTED IMMEDIATELY
 AFTER EACH RAINFALL AND AT LEAST DAILY
 DURING PROLONGED RAINFALL. ANY REQUIRED REPAIRS SHALL BE MADE IMMEDIATELY.
- 2. CLOSE ATTENTION SHALL BE PAID TO THE REPAIR OF DAMAGED SILT FENCE RESULTING FROM END RUNS AND UNDERCUTTING
- 3. SHOULD THE FABRIC ON A SILT FENCE DECOMPOSE OR BECOME INEFFECTIVE PRIOR TO THE END OF THE EXPECTED USABLE LIFE AND THE BARRIER STILL BE NECESSARY, THE FABRIC SHALL BE REPLACED PROMPTLY.
- 4. SEDIMENT DEPOSITS SHOULD BE REMOVED AFTER EACH STORM EVENT. THEY MUST BE REMOVED WHEN DEPOSITS REACH APPROXIMATELY ONE-HALF THE HEIGHT OF THE BARRIER
- 5. ANY SEDIMENT DEPOSITS REMAINING IN PLACE AFTER THE SILT FENCE IS NO LONGER REQUIRED. SHALL BE DRESSED TO CONFORM WITH THE EXISTING GRADE, PREPARED AND SEEDED.



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SUBMITTALS		
DATE	DESCRIPTION	REV.
05-28-13	ZONING REVIEW	
08-20-13	ZONING	
11-07-13	COUNTY COMMENTS	
02-19-14	COUNTY COMMENTS	
06-24-14	COUNTY COMMENTS	
08-08-14	COUNTY COMMENTS	





PROJECT NO:	1050.130
DESIGNER:	M.A.
ENGINEER:	M.M.

GRAPHIC SCALE IN INCHES

SEA 90-S-021 2232-Y13-10 **NOVEC - JOHNSON** SUBSTATION 15001 LEE HWY **CENTREVILLE, VA 20121**

EROSION AND SEDIMENT CONTROL **PLAN AND DETAILS**

SHEET NUMBER:

Z-2

MINIMUM STORMWATER INFORMATION FOR REZONING, SPECIAL EXCEPTION. SPECIAL PERMIT AND DEVELOPMENT PLAN APPLICATIONS

The following information is required to be shown or provided in all zoning applications, or a waiver request of the submission requirement with justification shall be attached. Note: Waivers will be acted upon separately. Pailure to adequately address the required submission information may result in a delay in processing this application.

This information is required under the following Zoning Ordinance paragraphs:

Special Permits (8-011 2J & 2L) Cluster Subdivision (9-615 1G & 1N) Development Plans PRC District (16-302 2 & 4L) PRC Plan (16-303 1E & 10) FDP P Districts (except PRC) 916-502 1F & 1Q) Amendments (18-202 10F & 10I)

Special Exceptions (9-011 2J & 2L) Commercial Revitalization Districts (9-622 2A (12)&(14))

1. Plat is at a minimum scale of 1"-50" (unless it is depicted on one sheet with a minimum scale of 1"-100).

2. A graphic depicting the stormwater management facility(ies) and limits of clearing and grading accommodate the stormwater management facility(ies), storm drainage pipe systems and outlet protection, pond spillways, access roads, site outfalls, energy dissipation devices, and stream stabilization measures as shown on Sheet

3. Provide: Off-Site are Drainage Footprint Storage If pond, dan served (acres) area (acres) area (sf.) Volume (cf.) height (ft.) Facility Name On-Site area Type & No. served (acres) to a thy pend A milk Trench, undercoverd vanil, etc. Totals

4. Onsite drainage channels, outfalls and pipe systems are shown on Sheet

5. Maintenance accesses (road) to stormwater management facility(ies) are shown on Sheet

6. Landscaping and tree preservation shown in and near the stormwater management facility is shown on Sheet.

7. A "stormwater management narrative" which contains a description of how detention and best management practices requirements will be met is provided on Sheet Z-2


8. A description of the existing conditions of each numbered site outfall extended downstream from the site to a point which is at least 100 times the site area or which has a drainage area of at least one square mile (640 acres) is provided on Sheet.

9. A description of how the outfall requirements, including contributing drainage areas of the Public Facilities Manual will be satisfied is provided on Sheet Z-2

10. Existing topography with maximum contour intervals of two (2) feet and a note as to whether it is an air survey or field run is provided on Sheets. Z-2

11. A submission waiver is requester for STORM WATER MANAGEMENT (QUALITY AND QUANTITY)

12. Stormwater management is not required because DISTURBED AREA IS SMALL AND THERE IS AN EXISTING SWM FACILITY ON SITE.

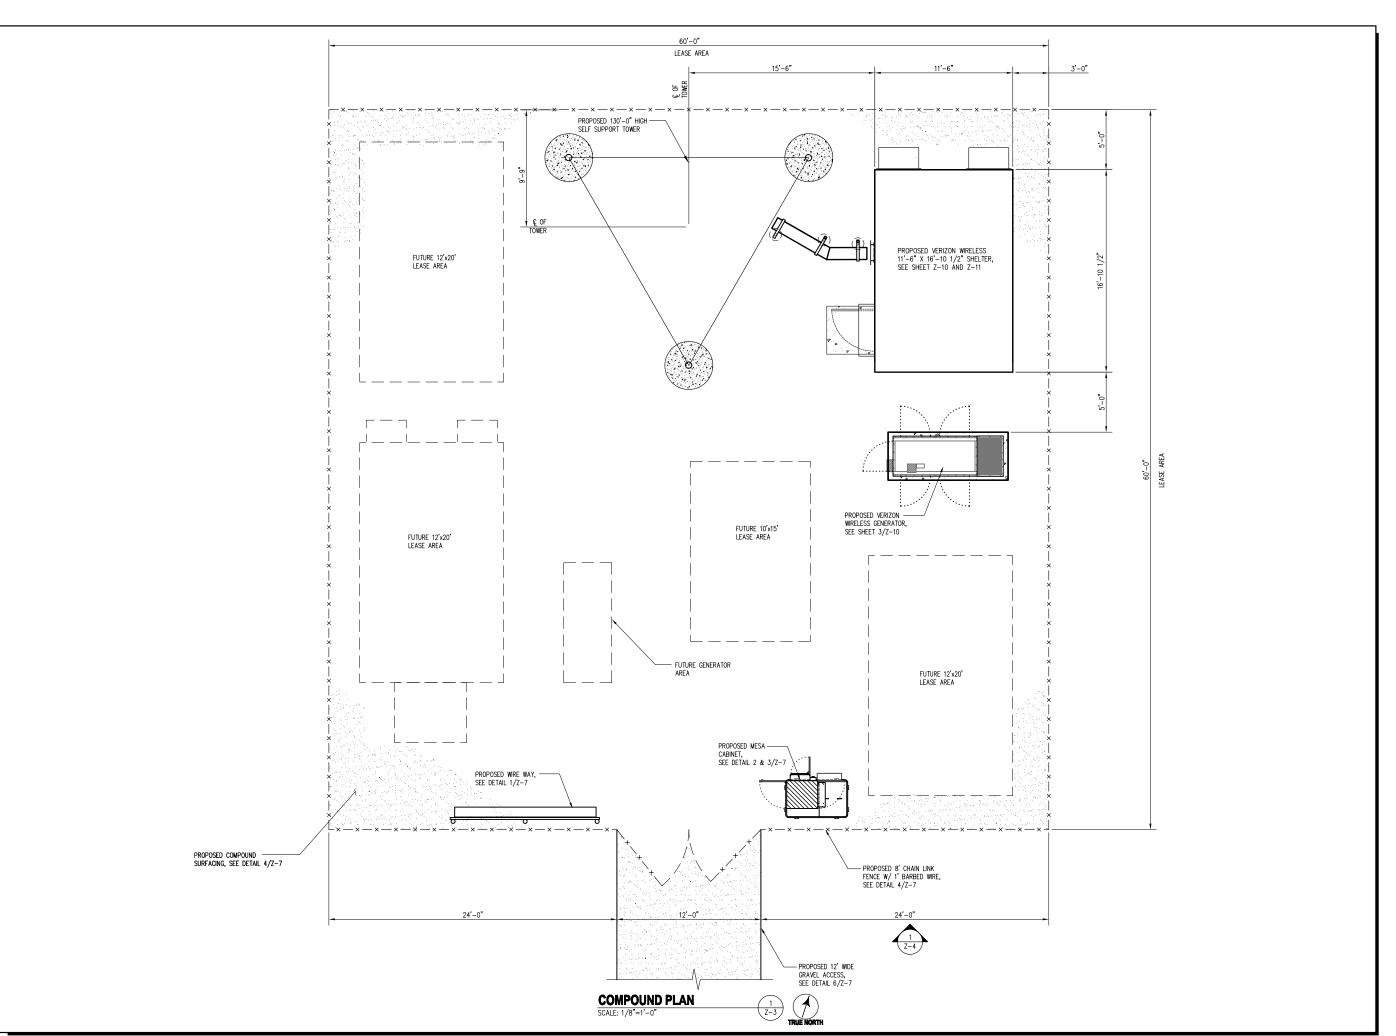



6600 Rockledge Drive, Suite 550 BETHESDA, MD 20817 PHONE: (202)408-0960 FAX: (202)408-0961

SUBMITTALS		
DATE	DESCRIPTION	REV.
05-28-13	ZONING REVIEW	
08-20-13	ZONING	
11-07-13	COUNTY COMMENTS	
02-19-14	COUNTY COMMENTS	
06-24-14	COUNTY COMMENTS	
08-08-14	COUNTY COMMENTS	





	PROJECT NO:	1050.130	
	DESIGNER:	M.M.	
	ENGINEER:	M.M.	

SCALE:




SEA 90-S-021 2232-Y13-10 NOVEC - JOHNSON SUBSTATION 15001 LEE HWY CENTREVILLE, VA 20121

TITLE:

COMPOUND PLAN

SHEET NUMBER:

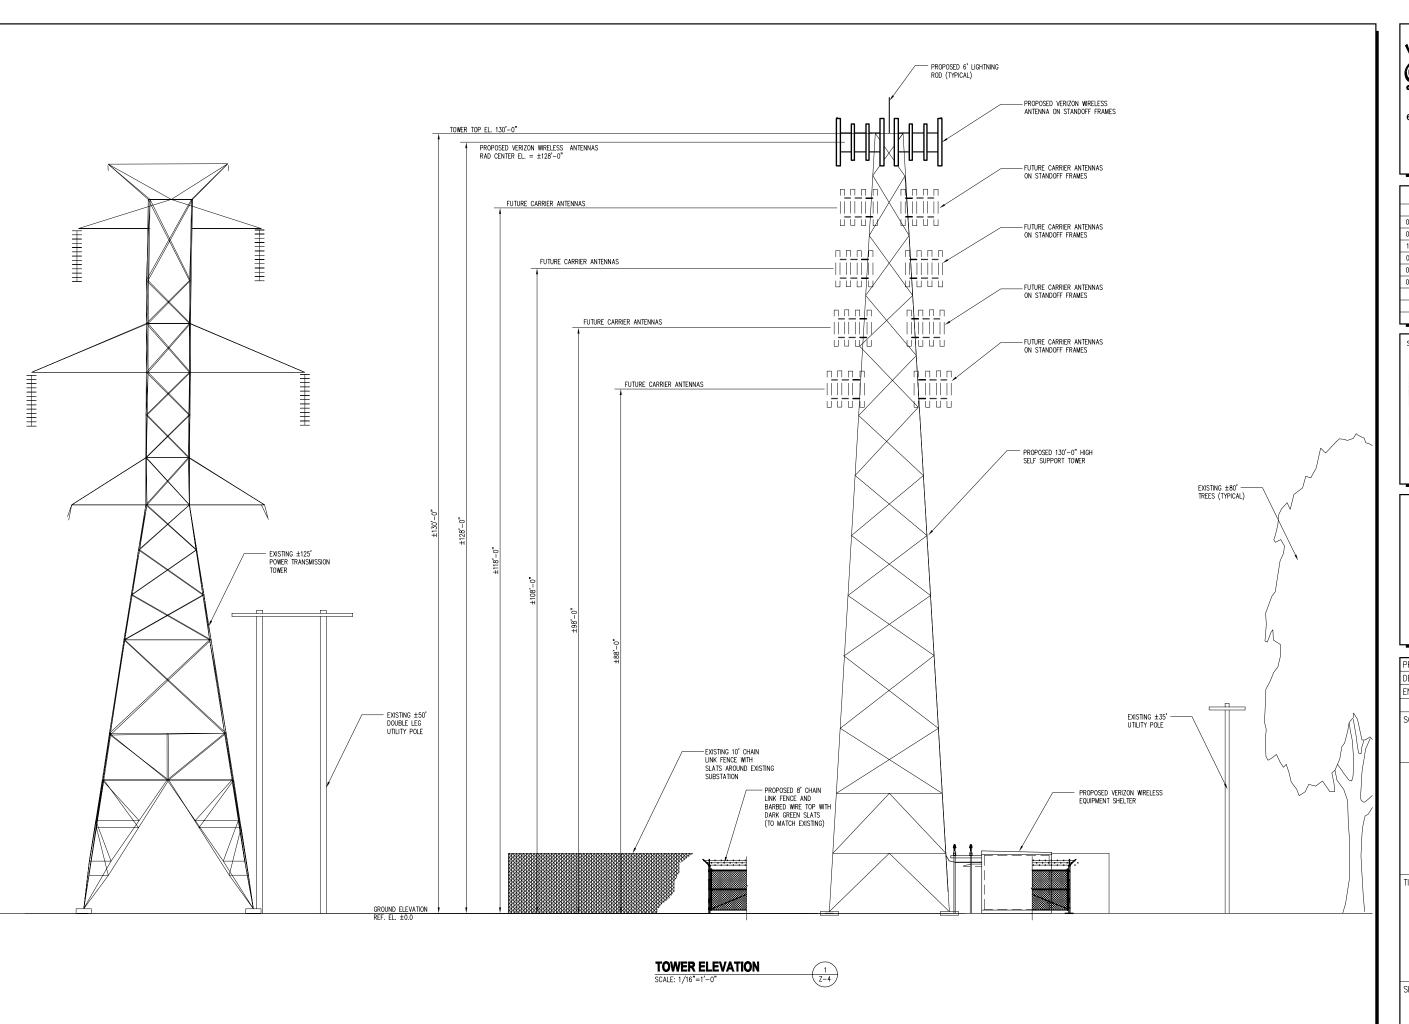



6600 Rockledge Drive, Suite 550 BETHESDA, MD 20817 PHONE: (202)408-0960 FAX: (202)408-0961

	SUBMITTALS				
DATE	DESCRIPTION	REV.			
05-28-13	ZONING REVIEW				
08-20-13	ZONING				
11-07-13	COUNTY COMMENTS				
02-19-14	COUNTY COMMENTS				
06-24-14	COUNTY COMMENTS				
08-08-14	COUNTY COMMENTS				






PROJECT NO:	1050.130	
DESIGNER:	M.A.	
ENGINEER:	M.M.	




SEA 90-S-021 2232-Y13-10 **NOVEC - JOHNSON** SUBSTATION 15001 LEE HWY **CENTREVILLE, VA 20121**

TOWER ELEVATION


SHEET NUMBER:

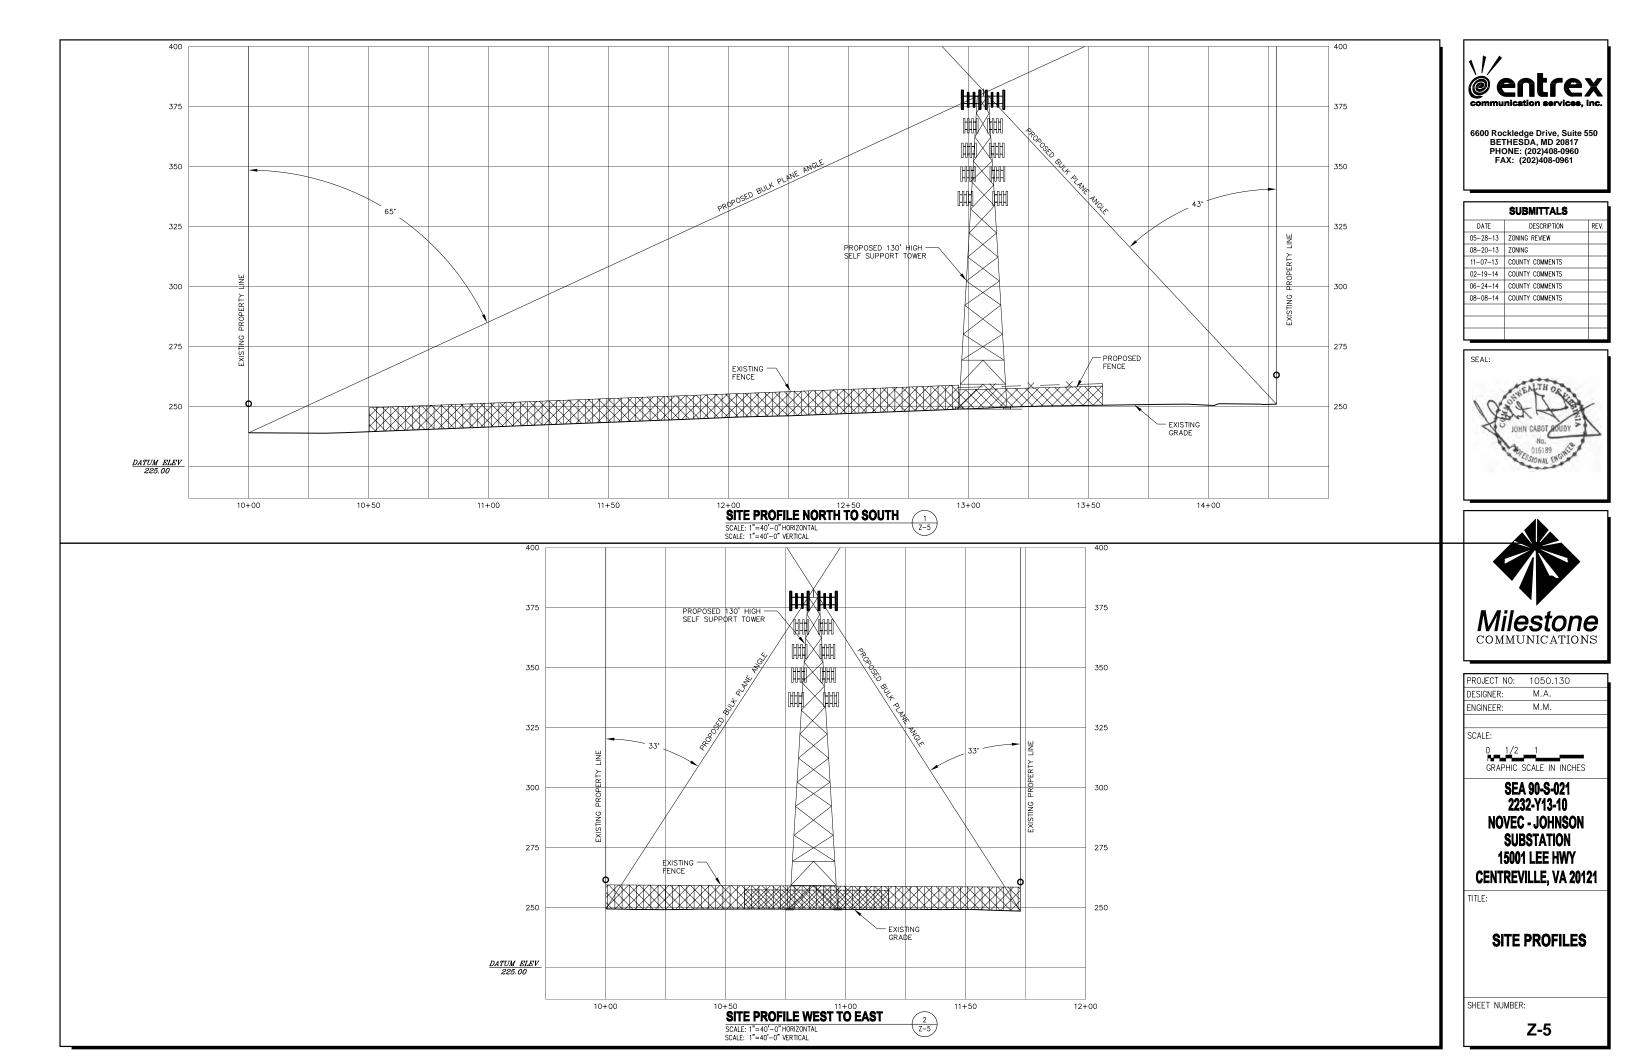

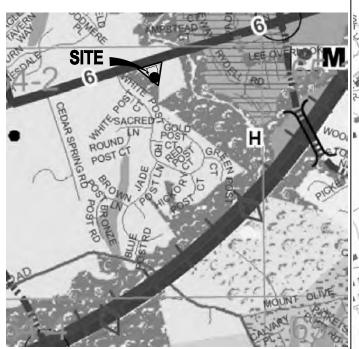




SOURCE: FAIRFAX COUNTY COMPREHENSIVE PLAN

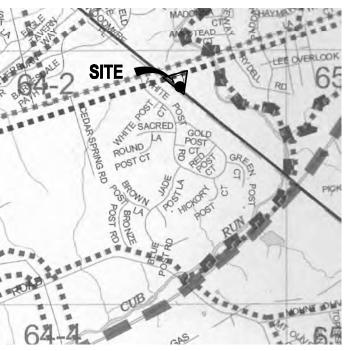



SOURCE: FAIRFAX COUNTY

NOTES: THERE IS A KNOWN NEARBY MAJOR PAVED TRAIL SYSTEM ALONG LEE HWY.

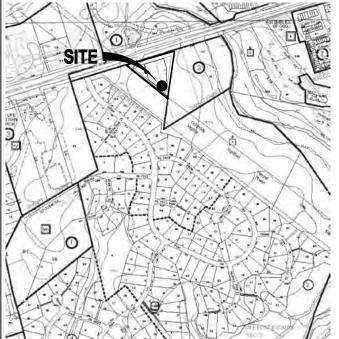




SOURCE: FAIRFAX COUNTY MAP SECTION 64-2

NOTE: SOIL TYPE: 63B SOIL NAME: JACKLAND AND HAYMARKET SOILS

SOIL TYPE: 95 SOIL NAME: URBAN LAND

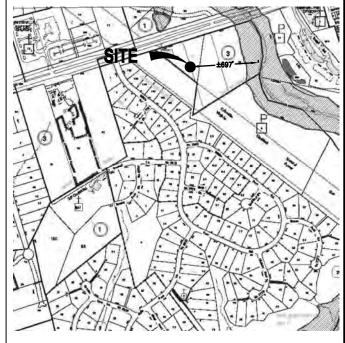

RESOURCE MANAGEMENT MAP

SOURCE: FAIRFAX COUNTY

NOTES:

THE PROJECT SITE IS LOCATED APPROXIMATELY 697 'FROM THE NEAREST RESOURCE PROTECTION AREA.







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SUBMITTALS


DESCRIPTION

DATE

05-28-13 ZONING REVIEW 11-07-13 COUNTY COMMENTS 02-19-14 COUNTY COMMENTS 06-24-14 COUNTY COMMENTS 08-08-14 COUNTY COMMENTS

PROJECT NO:	1050.130	
DESIGNER:	M.A.	
ENGINEER:	M.M.	

SCALE:

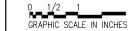


SEA 90-S-021 2232-Y13-10 **NOVEC - JOHNSON** SUBSTATION **15001 LEE HWY CENTREVILLE, VA 20121**

CIVIL MAPS

SHEET NUMBER:

Z-6

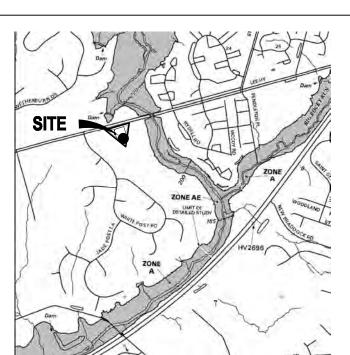



SOURCE: FEMA FLOOD MAP FOR FAIRFAX COUNTY, VA. COMMUNITY PANEL NUMBER 510559C 0230E. SEPTEMBER 17, 2010.

NOTES: THE PROJECT SITE IS LOCATED IN FLOOD ZONE X, AREAS DETERMINED TO BE OUTSIDE 500—YEAR FLOOD—PLAIN.








SOURCE: FAIRFAX COUNTY


NOTES: THE PROJECT SITE IS LOCATED IN A RESIDENTIAL AREA R-C.



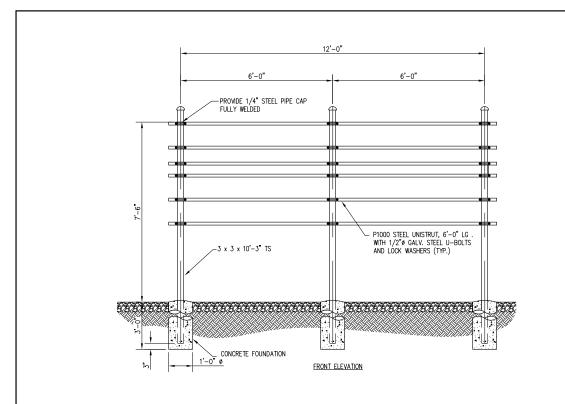

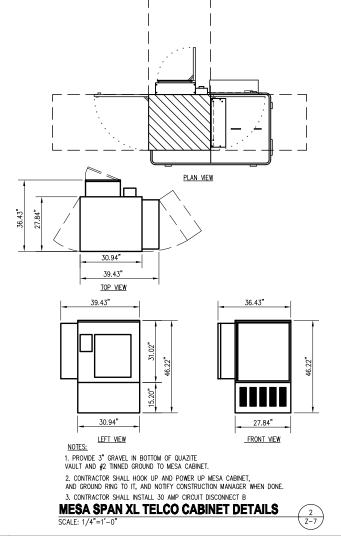

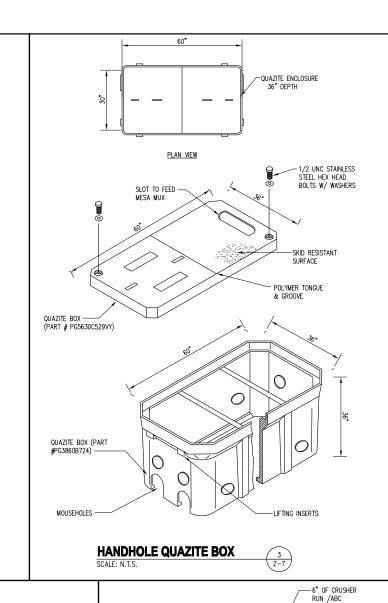

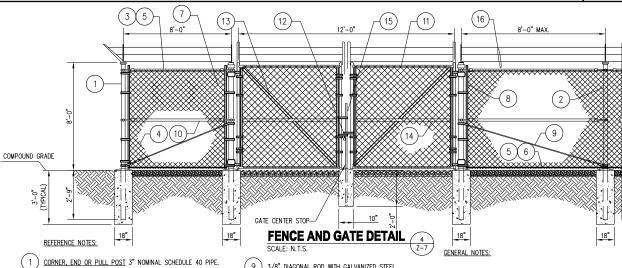

ELECTRICAL SERVICE FRAME

- 9 3/8" DIAGONAL ROD WITH GALVANIZED STEEL TURNBUCKLE OR DIAGONAL THREADED ROD.
- (11) GATE FRAME: 1 1/2" PIPE, PER ASTM-F1083.
- (12) MULTI-LOCKING DEVICE

(15) CENTER GATE STOP

(13) GATE DIAGONAL GALVANIZED STEEL 1 1/2" PIPE.

BARBED WIRE: DOUBLE STRAND 12-1/2" O.D. TWISTED WIRE TO MATCH WITH FABRIC 14 GA, 4 PT. BARBS SPACED ON

(14) GATE FRAME BRACE: 1 5/8" DIAMETER.

APPROXIMATELY 5" CENTERS.

(6) TENSION WIRE: 9 GA. GALVANIZED STEEL.

BY HOG RINGS SPACED MAX. 24" INTERVALS.

2 LINE POST: 2" SCHEDULE 40 PIPE, PER ASTM-F1083. LINE POSTS SHALL BE EQUALLY SPACED AT MAXIMUM 8'-0" O.C.


(3) TOP RAIL & BRACE RAIL: 1 1/2" PIPE, PER ASTM-F1083.

4 FABRIC: 9 GA CORE WIRE SIZE 2" MESH, CONFORMING TO

5 TIE WRE: MINIMUM 11 GA GALVANIZED STEEL AT POSTS AND RAILS A SINGLE WRAP OF FABRIC TIE AND AT TENSION WIRE

- 7 DARK GREEN SLATS TO MATCH EXISTING.
- (8) STRETCHER BAR.


ASTM-A392.

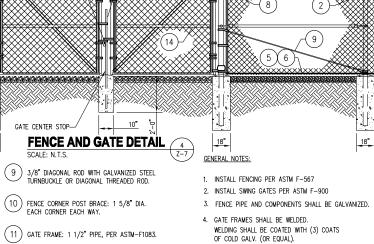

5. POSTS SHALL HAVE END-CAPS.


6. GATES SHALL HAVE LOCKING HARDWARE.

7. PROVIDE GATE STOPS TO SECURE GATES IN OPEN

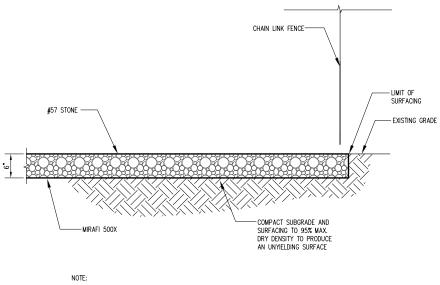

UTILITY AREA SHALL BE CLEARED AND GRUBBED. REMOVE UNSUITABLE LOOSE OR SOFT SOIL. ORGANIC MATERIAL OR RUBBLE TO FIRM GRADE. FILL UNDERCUT AND COMPACT UP TO 6"
BELOW FINISH GRADE. PLACE A MIRAFI 500X SOIL STABILIZATION FABRIC ON SUBGRADE. FILL WITH 6" OF AASHTO 57 STONE TO FINISH GRADE.

COMPOUND SURFACING DETAIL SCALE: N.T.S.

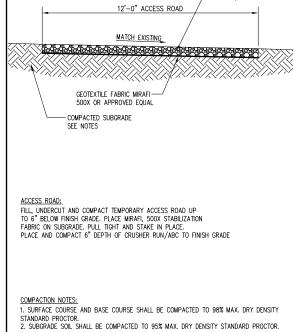


GRAVEL ACCESS ROAD DETAIL



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	SUBMITTALS				
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05-28-13	ZONING REVIEW				
08-20-13	ZONING				
11-07-13	COUNTY COMMENTS				
02-19-14	COUNTY COMMENTS				
06-24-14	COUNTY COMMENTS				
08-08-14	COUNTY COMMENTS				



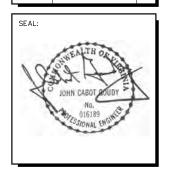


PROJECT NO: 1050.130

SITE DETAILS

15001 LEE HWY

CENTREVILLE, VA 20121

SHEET NUMBER:

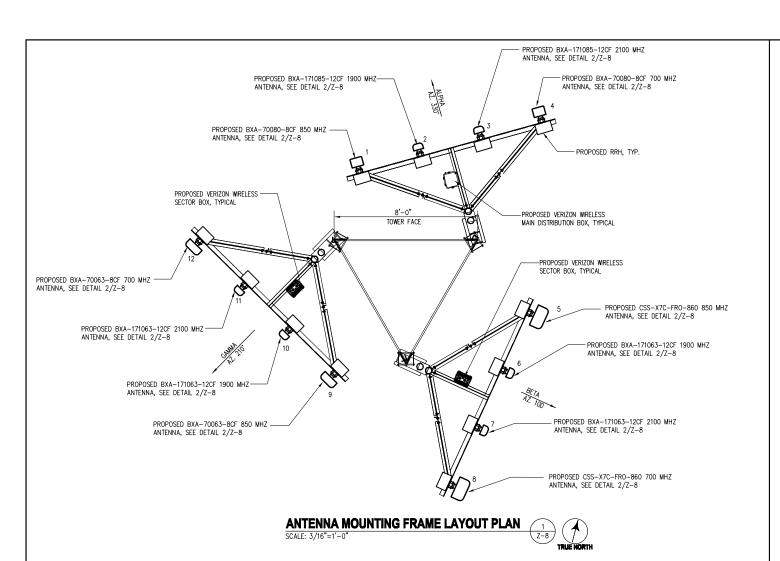

			ANTENNA AND	CABLE	SCHEDU	JLE			
ANTENNA SECTOR	ANTENNA MARK	RAD CENTER	ANTENNA	MECHANICAL DOWN-TILT	AZIMUTH	CABLE LENGTH	COAXIAL CABLE SIZE	COLOR CODE	FREQUENC
	# 1	128'-0"	BXA-70080-8CF (94.6" H x 8.0"W x 5.9" D)	-	330*	125'	(1) 6X12 HYBRID CABLE	R	850 MHZ
	# 2	128'-0"	BXA-171085-12CF (72.5" H x 6.1" W x 4.1" D)	-	330*	125'	(1) 6X12 HYBRID CABLE	0/R/0	1900 MHZ
ALPHA	# 3	128'-0"	BXA-171085-12CF (72.5" H x 6.1" W x 4.1" D)	-	330*	-	SHARED HYBRID CABLE	G/R/G	2100 MH
	# 4	128'-0"	BXA-70080-8CF (94.6" H x 8.0"W x 5.9" D)	-	330*	1	SHARED HYBRID CABLE	B/R/B	700 MHZ
	# 5	128'-0"	CSS-X7C-FRO-860 (96.0" H x 14.6" W x 8.0" D)	-	100*	-	SHARED HYBRID CABLE	BL	850 MHZ
	# 6	128'-0"	BXA-171063-12CF (72.5" H x 6.1" W x 4.1" D)	-	100*	-	SHARED HYBRID CABLE	0/BL/0	1900 MH
BETA	# 7	128'-0"	BXA-171063-12CF (72.5" H x 6.1" W x 4.1" D)	-	100°	=	SHARED HYBRID CABLE	G/BL/G	2100 MH
	# 8	128'-0"	CSS-X7C-FRO-860 (96.0" H x 14.6" W x 8.0" D)	-	100*	-	SHARED HYBRID CABLE	B/BL/B	700 MH
	# 9	128'-0"	BXA-70063-8CF (94.7" H x 11.2" W x 5.2" D)		210*	-	SHARED HYBRID CABLE	Y	850 MHZ
	# 10	128'-0"	BXA-171063-12CF (72.5" H x 6.1" W x 4.1" D)	-	210°	-	SHARED HYBRID CABLE	0/Y/0	1900 MH
GAMMA	# 11	128'-0"	BXA-171063-12CF (72.5" H x 6.1" W x 4.1" D)	-	210°	-	SHARED HYBRID CABLE	G/Y/G	2100 MH
	# 12	128'-0"	BXA-70063-8CF (94.7" H x 11.2" W x 5.2" D)	-	210*	-	SHARED HYBRID CABLE	B/Y/B	700 MH:
GPS	-	-	MAXRAD GPS-TMG-HR-26N	-	-		1/2"ø	-	-

NOTES:

- ALL ANTENNAS SHALL BE FURNISHED WITH DOWNTILT BRACKETS. CONTRACTOR SHALL COORDINATE REQUIRED MECHANICAL DOWNTILT FOR EACH ANTENNA WITH RF ENGINEER. ANTENNA DOWNTILT SHALL BE SET AND VERIFIED BY A SMART LEVEL.
- 2. ANTENNA CENTERLINE HEIGHT IS IN REFERENCE TO ELEVATION 0.0'.
- 3. FINAL CABLE LENGTHS SHALL BE DETERMINED AFTER INSTALLATION.
- 4. COORDINATE THE ANTENNA DOWNTILT WITH THE RF ENGINEER.
- 5. THE CABLE LENGTHS SHOWN ARE THE ACTUAL COMPUTED LENGTHS WITH NO OVERAGE ALLOWANCE.

	7/8"	ø RF	1-1/4"ø RF	1-5/8"ø RF	2-1/4 " ø RF	1.1"ø HYBRIFLEX
CABLE MINIMUM BEND RADIUS						
	-	-		1/2 " ø	-	-
	-	210*	- :	SHARED HYBRID CAI	BLE B/Y/B	700 MHZ
	-	210*	- 9	SHARED HYBRID CAE	G/Y/G	2100 MHZ
	-	210*	- :	SHARED HYBRID CAI	BLE 0/Y/0	1900 MHZ
		210*	- :	SHARED HYBRID CAI	BLE Y	850 MHZ

20"

15"


22"

10"



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06-24-14	COUNTY COMMENTS	
08-08-14	COUNTY COMMENTS	



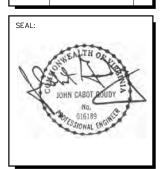

PROJECT NO:	1050.130	
DESIGNER:	M.A.	
ENGINEER:	M.M.	

SCALE:

GRAPHIC SCALE IN INCHES

SEA 90-S-021 2232-Y13-10 **NOVEC - JOHNSON** SUBSTATION 15001 LEE HWY CENTREVILLE, VA 20121


ANTENNA SCHEDULE **AND DETAILS**


SHEET NUMBER:

Z-8

ANTENNA MODEL (SX-7/OB80-BC7 (94.6" H x 8.0" W x 5.9" D) ANTENNA MODEL (SX-7/OB80-BC7 (72.5" H x 6.1" W x 4.1" D) ANTENNA MODEL (S		10P VIEW	TOP VIEW	10P VIEW	TOP VIEW
6.1" 4.1" 11.2 5.2. 6.1" 4.1" 4.1" 5.2. 6.1" 4.1" 6.1" 6.1" 6.1" 6.1" 6.1" 6.1" 6.1" 6	MODEL BXA-70080-8CF	ANTENNA MODEL BXA-171085-12CF (72.5" H x 6.1" W x 4.1" D)	MODEL CSS-X7C-FRO-860	ANTENNA MODEL BXA-171063-12CF (72.5" H x 6.1" W x 4.1" D)	ANTENNA MODEL BXA-70063-8CF (94.7" H x 11.2" W x 5.2" D)
	94.6"	72.5"	96.0"	72.5°	94.7*

ANTENNA DETAILS

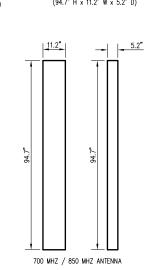


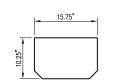



PROVIDE FITTING — FOR EXTENSION OF HYBRIFLEX CABLES - PROVIDE FITTING FOR EXTENSION OF LIQUATITE WIRELESS EQUIPMENT

PLAN VIEW

BOTTOM VIEW

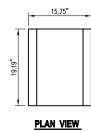


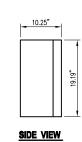

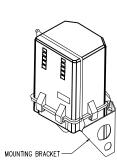

MANUFACTURER: RAYCAP DIMENSIONS: 10.25Dx15.73Wx19.18"H WEIGHT 21.4 LBS (SYSTEM) 5.5 LBS (MOUNT) 26.9 LBS (TOTAL)

MAIN DISTRIBUTION BOX DETAILS (1 Z-9)

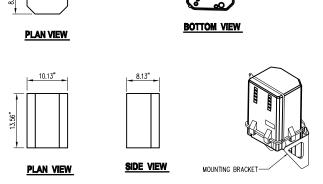

000°


PROVIDE FITTING-FOR EXTENSION OF HYBRIFLEX CABLES TO REMOTE RADIO HEADS

HYBRIFLEX CABLES FROM MAIN DISTRIBUTION BOX

MANUFACTURER: RAYCAP DIMENSIONS: 8.15Dx 10.15W x13.58"H WEIGHT 8.9 LBS (SYSTEM) 3.2 LBS (MOUNT) 12.1 LBS (TOTAL)

SECTOR DISTRIBUTION BOX DETAILS

10.13"

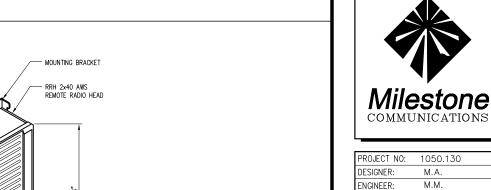

SCALE: 0 1/2 1 GRAPHIC SCALE IN INCHES

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SUBMITTALS

DESCRIPTION

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SEAL:

05-28-13 ZONING REVIEW

11-07-13 COUNTY COMMENTS 02-19-14 COUNTY COMMENTS 06-24-14 COUNTY COMMENTS 08-08-14 COUNTY COMMENTS

08-20-13 ZONING


SEA 90-S-021 2232-Y13-10 **NOVEC - JOHNSON** SUBSTATION **15001 LEE HWY**

RRH AND DISTRIBUTION BOX DETAILS

CENTREVILLE, VA 20121

SHEET NUMBER:

Z-9

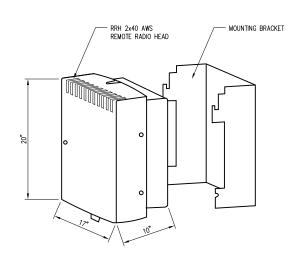


MANUFACTURER: ALCATEL-LUCENT POWER SUPPLY: 48 VDC DIMENSION:10"Dx17"Wx20"H WEIGHT: 51 LBS WITH MOUNTING HARDWARE

NOTE:

1. INSTALL RRH PER MANUFACTURE RECOMMENDATION.

2. FIBER, DC POWER AND GROUND CONNECTION NOT SHOWN.

700 MHz LTE RRH DETAIL

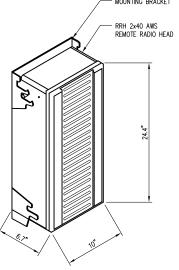


MANUFACTURER: ALCATEL-LUCENT POWER SUPPLY: 48 VDC DIMENSION: 6.7"Dx10.63"Wx24.4"H WEIGHT: 44 LBS

INSTALL RRH PER MANUFACTURE RECOMMENDATION.
 FIBER, DC POWER AND GROUND CONNECTION NOT SHOWN.

2100 MHz AWS RRH DETAIL

SCALE: N.T.S.



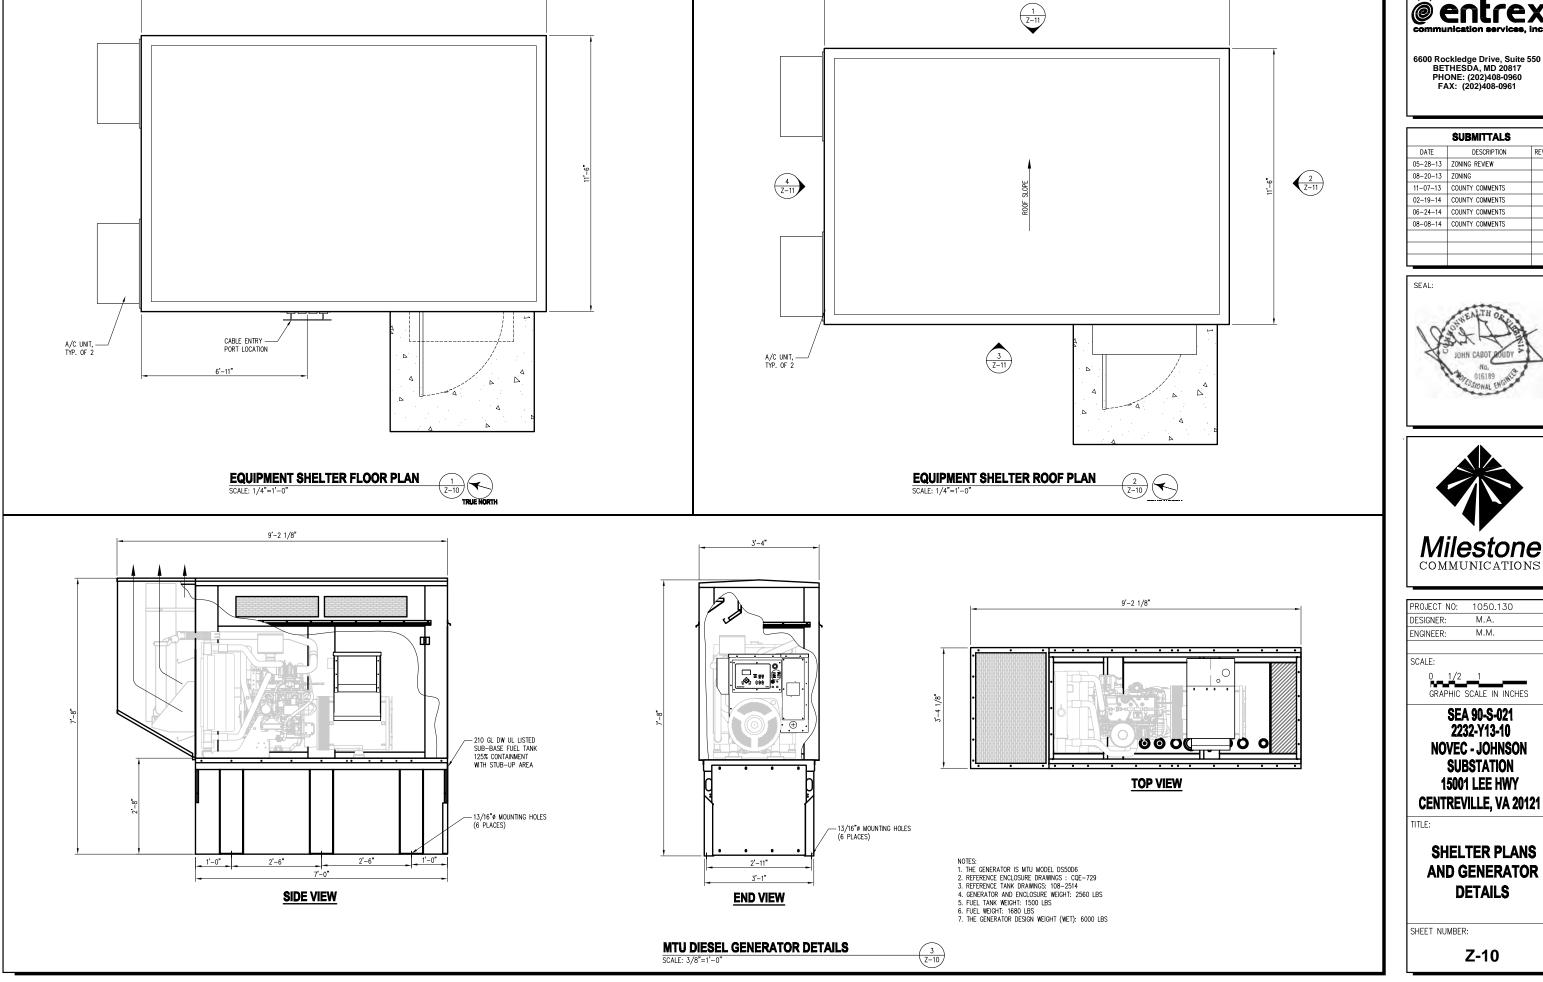

16'-10 1/2"

16'-10 1/2"



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08-08-14	COUNTY COMMENTS					







0 1/2 1	SI 2	EA 90-S-021 232-Y13-10 EC - JOHNSON
	ENGINEER:	M.M.
ENGINEER: M.M.	DESIGNER:	IVI.A.
DESIGNER: M.A. ENGINEER: M.M.	DECICNED.	MA

SHELTER PLANS AND GENERATOR DETAILS


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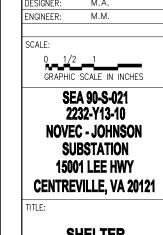


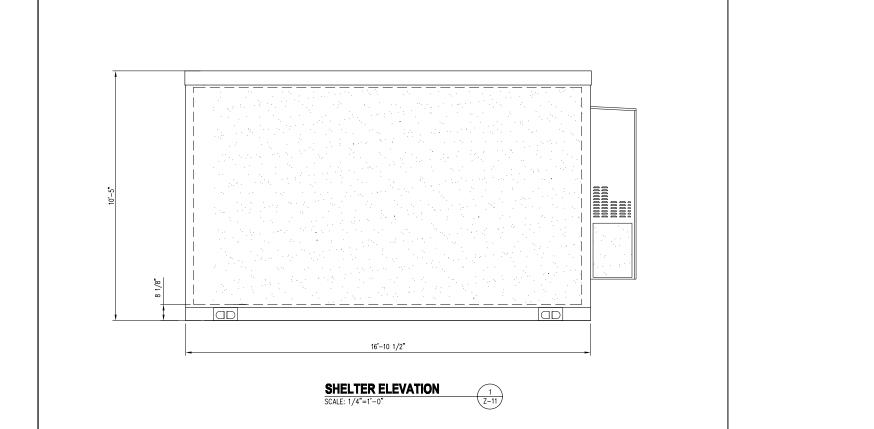

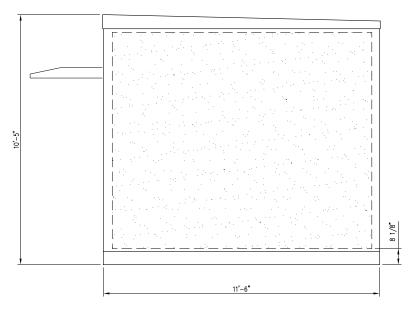SHELTER ELEVATION

SHELTER ELEVATION



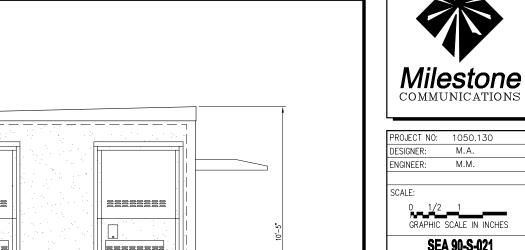

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SUBMITTALS

DESCRIPTION

DATE

SEAL:


05-28-13 ZONING REVIEW 11-07-13 COUNTY COMMENTS 02-19-14 COUNTY COMMENTS 06-24-14 COUNTY COMMENTS 08-08-14 COUNTY COMMENTS


> **SHELTER ELEVATIONS**


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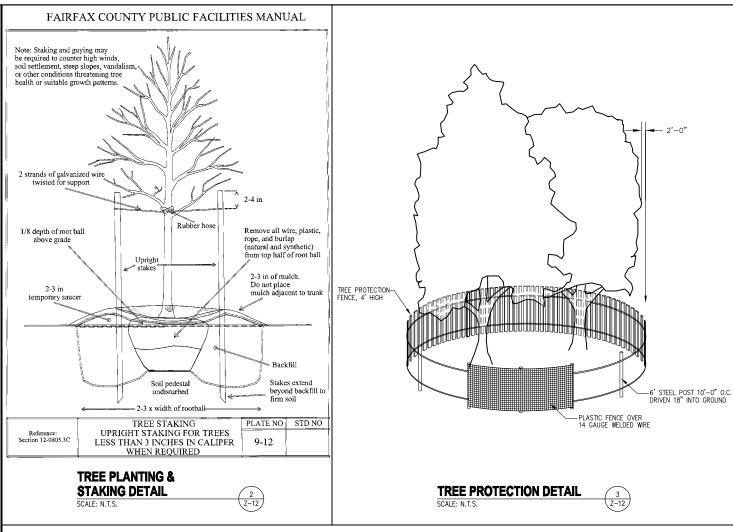
Z-11

======= 11'-6"



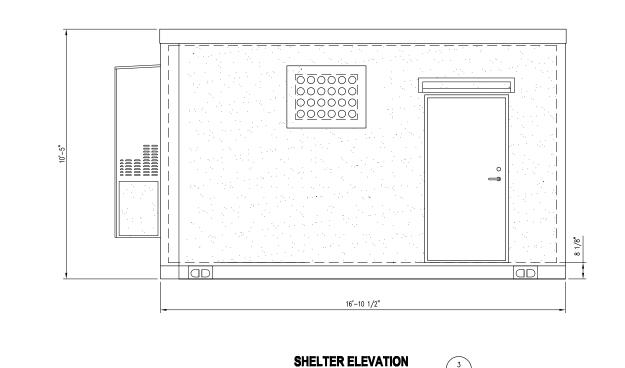

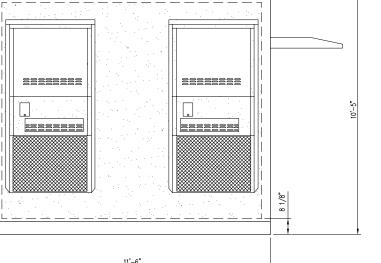

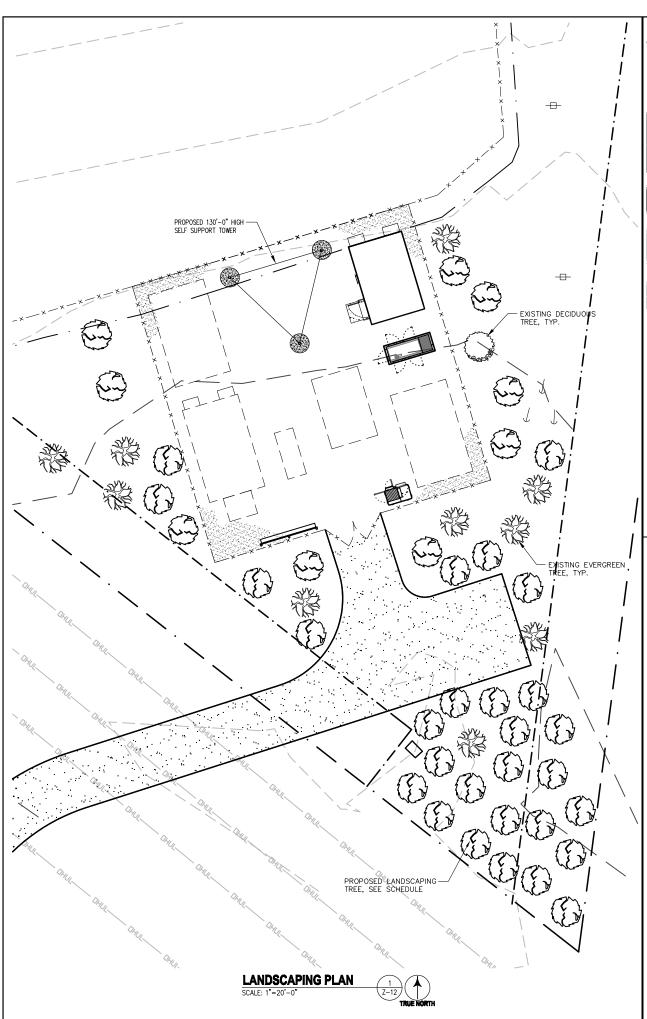

LEGEND



EXISTING EVERGREEN TREE



EXISTING DECIDUOUS TREE

PLANTING SCHEDULE

BOTANICAL NAME	COMMON NAME	CALIPER	HEIGHT	SPREAD	QUANTITY	REMARKS	SYMBOL
JUNIPERUS VIRGINIANA	EASTERN RED CEDAR	± 2"	± 8'-0"	24"-36"	37	FULL, DENSE	6

TREE PLANTING NOTES:

- -EXCAVATE 'PLANTING PIT' TWICE THE DIAMETER OF BALL $\,\,\&\,\,6$ GREATER IN DEPTH.

- IN DEPTH.

 -LOOSEN SUBSOIL W/PICK TO ENSURE POROSITY
 -PLACE 6" PEAT MOSS IN 'PLANTING PIT' & TAMP
 -SELECT BEST VIEWING ANGLE, LIFT STOCK BY BALL & PLACE IN
 'PLANTING PIT'
 -UNWRAP TOP HALF OF BALL BACK
 -FILL W/MIXTURE 1/3 PEAT MOSS-2/3 TOP- SOIL & TAMP
 -WRAP TRUNK W/PAPER TAPE TO FIRST BRANCH

- -LAY-IN (POROUS) FABRIC WEED BARRIER FORM 3" SAUCER TO ENCIRCLE STOCK
- -FILL W/3" PINE STRAW MULCH
 -FLOOD IMMEDIATELY & WATER FREQUENTLY



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PROJECT NO:	1050.130
DESIGNER:	M.A.
FNGINFFR:	M.M.


SCALE:



SEA 90-S-021 2232-Y13-10 **NOVEC - JOHNSON** SUBSTATION **15001 LEE HWY CENTREVILLE, VA 20121**

LANDSCAPE PLAN, **DETAILS AND NOTES**

SHEET NUMBER:

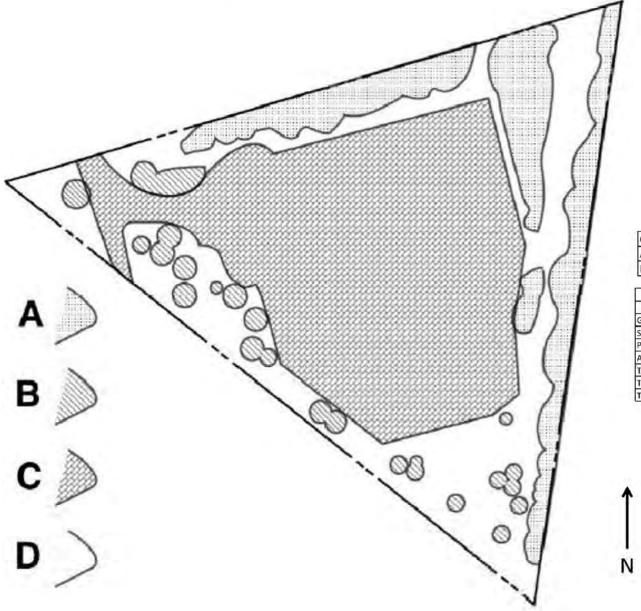

10-Year Tree Canopy

15001 Lee Hwy. Centreville, VA

Cover Type	Canopy Area (sq. ft.)
A - Forested/Early Successional (1.5 X)	20887
B - Developed/Free-standing trees	3573

10-year Tree Canopy Calculations	
Gross site area =	120,156
Site Zoning	R-C
Percentage of 10-year tree canopy required	30
Area of 10-year tree canopy required	36,047
Total of canopy area provided through tree preservation	30,575
Total of canopy area provided through tree planting	5,550
Total of 10-year Tree Canopy Provided	36,125

Prepared by:

SAVAYREE

The Consulting Group

June 23, 2014

_		
Ta	ble 12.3 Tree Preservation Target Calculations and Statement	
А	Pre-development area of existing tree canopy (from Existing Vegetation Map) =	30,575
В	Percentage of gross site area covered by existing tree canopy -	29%
С	Percentage of 10-year tree canopy required for site (see Table 12.4) =	30
D	Percentage of the 10-year tree canopy requirement that should be met through tree preservation $\bar{\ }$	
Б	Proposed percentage of canopy requirement that will be met through tree preservation =	
F	Has the Tree Preservation Target minimum been met?	Yes
G	If No for line F, then a request to deviate from the Tree Preservation Target shall be provided on the plan that states one or more of the justifications listed in § 12-0598.3 along with a nurative that provides a site-specific explanation of Why the Tree Preservation Target cannot be met. Provide sheet number where deviation request is located.	
Η	If step G requires a narrative, it shall be prepared in accordance with § 12-0508.4	
Ī	Place this information prior to the 10-year Tree Canopy Calculations as per instructions in Table 12.10.	

Step		Totals	Reference
A. Tre	ee Preservation Target and Statement		
Al	Place the Tree Preservation Target calculations and statement here preceding the 10-year tree canopy calculations		see § 12-0508.2 for list of required elements an worksheet
B. Tro	ec Canopy Requirement		
Bl	Identify gross site area =	120,156	§ 12-0511.1A
B2	Subtract area dedicated to parks, road frontage, and		§ 12-0511.1B
B3	Subtract area of exemptions =		§ 12-0511.1C(1) through § 12-0511.1C(
В4	Adjusted gross site area (B1 – B2)		
B5	Identify site's zoning and/or use	R-C	
В6	Percentage of 10-year tree canopy required -	30	§ 12-0510.1 and Table 12.4
B7	Area of 10-year tree canopy required (B4 x B6) =	36,047	
138	Modification of 10-year Tree Canopy Requirements requested?		Yes or No
B9	If B8 is yes, then list plan sheet where modification request is located		Sheet number
C. Tre	ee Preservation		
CI	Tree Preservation Target Area =		
C2	Total canopy area meeting standards of § 12-0400 -	24.460	
C3	C2 x 1 25 =	30.575	§ 12-0510.3B

C4	Total canopy area provided by unique or valuable forest		
	or woodland communities =		
C5	C4 x 1.5 =		§ 12-0510.3B(1)
C6	Total of canopy area provided by "Heritage," "Memorial," "Specimen." or "Street" trees		
C7	C6 x 1.5 to 3.0 =		§ 12-0510.3B(2)
J8	Canopy area of trees within Resource Protection Areas and 100-year floodplains =		
C9	C8 x 1.0 =		§ 12-0510.3C(1)
C10	Total of C3, C5, C7 and C9 –	30,575	If area of C10 is less than B7 then remainder of requirement must be met through tree planting - go to D
D. Tr	ee Planting		
D1	Area of canopy to be met through tree planting (B7-C10) =	3,700	
D2	Area of canopy planted for air quality benefits -		
D3	x 1.5 =		§ 12-0510.4B(1)
D4	Area of canopy planted for energy conservation -		
D5	x 1.5 =		§ 12-0510.4B(2)
D6	Area of canopy planted for water quality benefits -		
D7	x 1.25 =		§ 12-0510.4B(3)
D8	Area of canopy planted for wildlife benefits -		
D9	x 1.5 =		§ 12-0510.4B(4)
D10	Area of canopy provided by native trees =	3,700	
DH	x 1.5 -	5,550	§ 12-0510.4B(5)
D12	Area of canopy provided by improved cultivars and		
D13	x 1.25	_	§ 12-0510.4B(6)
D14	Area of canopy provided through tree seedlings		
	x 1.0		§ 12-0510.4D(1)
D15	Area of canopy provided through native shrubs		
	x1.0		§ 12-0510.4D(1)
D16	Percentage of D14 represented by D15		Must not exceed 33% of
D17	Total of canopy area provided through tree planting =		
D18	Is an off-site planting relief requested?		Yes or No
D19	Tree Bank or Tree Fund?		§ 12-0512
D20	Canopy area requested to be provided through off-site		
D21	Amount to be deposited into the Tree Preservation and	1	
	tal of 10-year Tree Canopy Provided		
E1	Total of canopy area provided through tree preservation (C10) =	30,575	
E2	Total of canopy area provided through tree planting (D17) =	5,550	
E3	Total of canopy area provided through off-site mechanism (D19) –		
E4	Total of 10-year Tree Canopy Provided = (B1-E2+E3)	36,125	Total of E1 through E3. Area should meet or exceed area required by B7



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SUBMITTALS				
DATE	DESCRIPTION	REV.		
05-28-13	ZONING REVIEW			
08-20-13	ZONING			
11-07-13	COUNTY COMMENTS			
02-19-14	COUNTY COMMENTS			
06-24-14	COUNTY COMMENTS			
08-08-14	COUNTY COMMENTS			





DESIGNER:	M.A.
ENGINEER:	M.M.
SCALE:	
0 _ 1/2	_1
GRAPHIC	SCALE IN INCHES


PROJECT NO: 1050.130

SEA 90-S-021 2232-Y13-10 NOVEC - JOHNSON SUBSTATION 15001 LEE HWY CENTREVILLE, VA 20121

TITLE

TREE CANOPY CALCULATION

SHEET NUMBER:

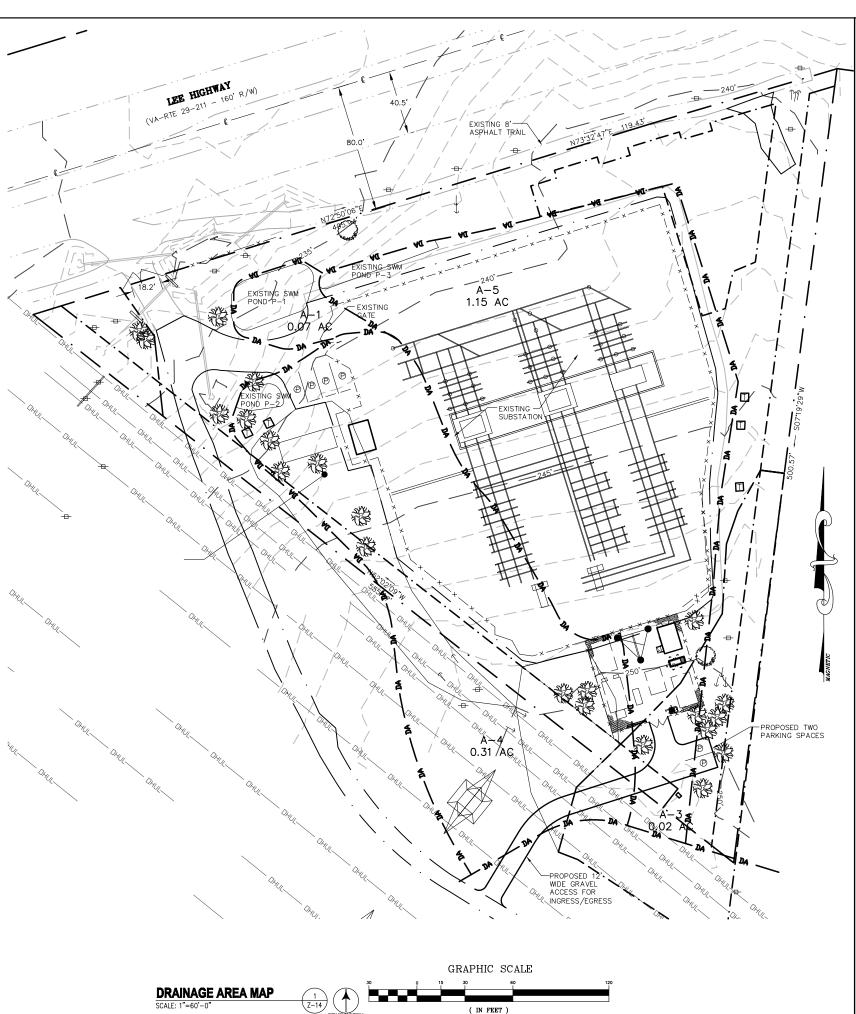

1 inch = 60 ft

OUTFALL NARRATIVE

THIS PROJECT PROPOSES A GRAVEL COMPOUND FOR TELECOMMUNICATIONA AND GRAVEL ACCESS ROAD. THE INCREASE IN RUNOFF SUE TO THIS PROJECT WILL BE HANDLED BY THREE ON SITE EXISTING PONDS. DUE TO MINIMAL INCREASE IN DISTURBED AREA, THE PRE DEVELOPMENT AND POST DEVELOPMENT RUNOFF COEFFICIENT FOR THE DRAINAGE AREA GOING TO THE EXISTING PONDS AND ALMOST SAME. THE TOTAL INCREASE IN RUNOFF DUE TO THE SITE IS 0.13 CFS WHICH WILL FLOW AS SHEET FLOW TO THE PROPOSED BMPS BEFORE ENTERING THE EXISTING PONDS. HENCE, THERE WILL BE NO ADVERSE EFFECT OR IMPACT ON THE EXISTING CONDITION OF THE DOWNSTREAM PROPERTIES AFTER THIS DEVELOPMENT.

EXISTING SWM AND BMP

THERE ARE THREE ONSITE DRY PONDS, POND 1, 2 AND 3 AND ARE LOCATED ABOVE THE EXISTING SITE OUTFALL AT ROUTE 29 ADJACENT TO THE EXISTING GRAVEL ENTRANCE. THE DRAINAGE AREA FOR THESE PONDS ARE LEBELLED AS AREA 1 THROUGH 5.

AREA A-1 AND A-5 ARE ONSITE CONTROLLED, A-2 IS ONSITE UNCONTROLLED (BMP CONTROLLED) AND AREA A-3 AND A-4 ARE OFFSITE BMP CONTROL

DRAINAGE AREA A-2 AND A-4 DRAINS TO POND P-2. DRAINAGE AREA A-3 AND A-5 DRAINS TO POND P-3 AND EXCESS RUNOFF FROM P-3 SPILLS INTO THE ADJACENT POND P-1. POND P-1 ALSO HAVE DRAINAGE AREA A-1.

EXSING AREA AND RUNOFF COEFFICIENT FOR ALL DRAINAGE AREAS:

AREA (AC) RUNOFF COEFFICEINT "C" 0.08 0.58 0.02 0.44 0.38 0.30 0.32 A-4: A-5: 0.31 1.15 0.32

PROPOSED CONDITION

PROPOSED GRAVEL COMPOUND AND GRAVEL ACCESS DRIVE ARE ON DRAINAGE AREA A-2, A-4 AND A-5. PROPOSED AREA ON:
A-2: 0.02 AC
A-4: 0.02 AC
A-5: 0.07 AC

RAINFALL INTENSITY

(ALL RAINFALL INTENSITY ARE USED FOR 5 MIN. TRAVEL TIME) 2 YR: 5.45 IN/HR 10 YR: 7.27 IN/HR

CALCULATIONS

POND 1 PRE-DEVELOPMENT CONDTION: TOTAL AREA: 1.25 AC, C: 0.33

DRAINAGE AREA A-5

PRE-DEVELOPMENT CONDTION: DA: 1.15, C: 0.32

POST-DEVELOPMENT CONDTION: REPLACING 0.07 AC OF GRASSED AREA (C: 0.35) WITH GRAVEL AREA (C: 0.6) WEIGHTED C: 0.33

WEIGHTED C FROM DRAINAGE AREA A-1, A-3 AND A-5 GOING TO P-1

C = (((0.08*0.44) + (1.15*0.331) + (0.02*0.3))/1.25 = 0.336 WHIS IS ALMOST EQUAL TO PRE-DEVELOPMENT CONDITION.

PRE-DEVELOPMENT FLOW: 2 YR: 0.33X5.45X1.25 = 2.24 CFS 10 YR: 0.33X7.27X1.25 = 2.76 CFS POST-DEVELOPMENT FLOW:

2 YR: 0.336X5.45X1.25 = 2.29 CFS 10 YR: 0.336X7.27X1.25 = 2.80 CFS

POND 2 PRE-DEVELOPMENT CONDTION: TOTAL AREA: 0.89 AC, C: 0.32

DRAINAGE AREA A-2

PRE-DEVELOPMENT CONDTION: DA: 0.58, C: 0.38

POST-DEVELOPMENT CONDTION: REPLACING 0.02 AC OF GRASSED AREA (C: 0.35) WITH GRAVEL AREA (C: 0.6) WEIGHTED C: 0.384

DRAINAGE AREA A-4

PRE-DEVELOPMENT CONDTION: DA: 0.31, C: 0.32

POST-DEVELOPMENT CONDTION: REPLACING 0.02 AC OF GRASSED AREA (C: 0.35) WITH GRAVEL AREA (C:0.6) WEIGHTED C: 0.33

WEIGHTED C FROM DRAINAGE AREA A-2 AND A-4 GOING TO P-2

 ${\tt C = ((0.58*0.384)+(0.31*0.32))/0.89 = 0.324~WHIS~IS~ALMOST~EQUAL~TO~PRE-DEVELOPMENT~CONDITION.} \\$

PRE-DEVELOPMENT FLOW: 2 YR: 0.32X5.45X0.89 = 1.55 CFS 10 YR: 0.32X7.27X0.89 = 2.07 CFS

POST-DEVELOPMENT FLOW: 2 YR: 0.324X5.45X0.89 = 1.57 CFS 10 YR: 0.324X7.27X0.89 = 2.09 CFS



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ZONING				
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PROJECT NO:	1050.130	
DESIGNER:	M.A.	
ENGINEER:	M.M.	


SCALE:



SEA 90-S-021 2232-Y13-10 **NOVEC - JOHNSON SUBSTATION 15001 LEE HWY CENTREVILLE, VA 20121**

DRAINAGE AREA MAP AND **CALCULATIONS**

SHEET NUMBER:

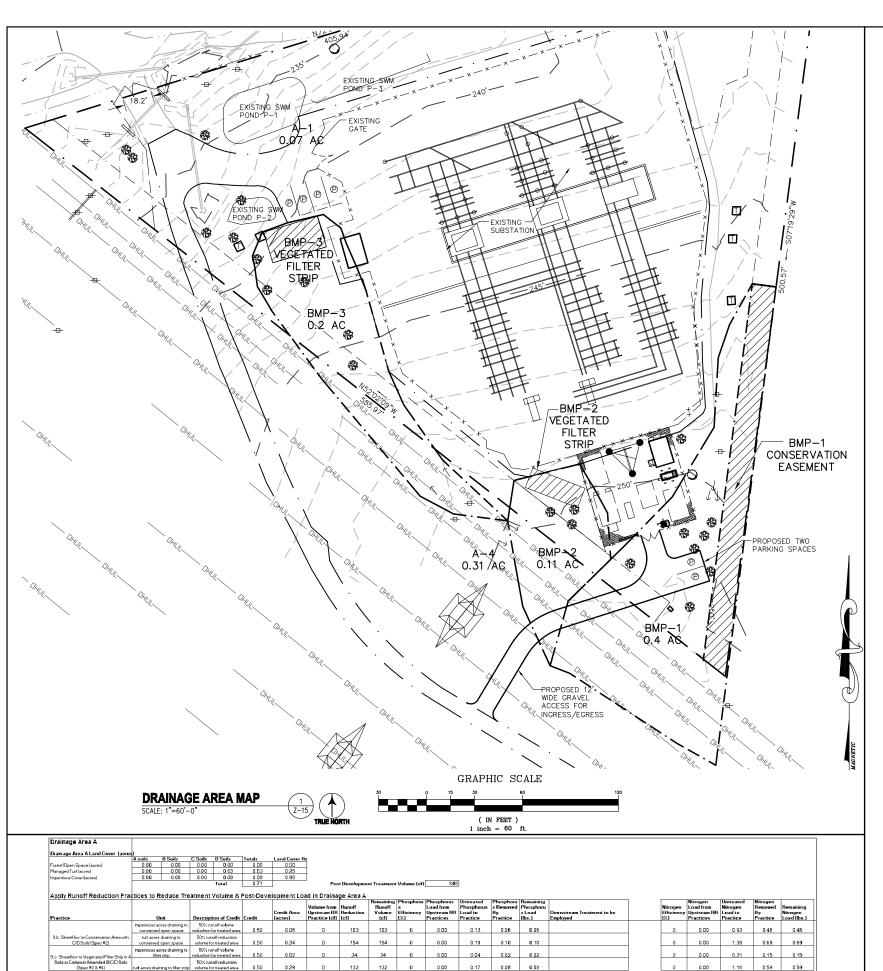

TOTAL RUNOFF REDUCTION IN D.A. A (6f) 424
NITROGEN REMOVAL FROM RUNOFF REDUCTION PRACTICES IN D.A. A (lb/yr) 3.81

TOTAL IMPERVIOUS COVER TREATED (ac) 0.08
TOTAL TURF AREA TREATED (ac) 0.63

AREA CHECK OK.

Site Data	Revised April 2014				
Project Name: NOVEC- JOHNSON S	UBSTATION				
Date: 08/07/2014					
	data input cells				
	calculation cells				
	constant values				
1. Post-Development Project	& Land Cove	er Information			
Constants					
Constants					
Annual Rainfall (inches)	43				
Target Rainfall Event (inches)	1.00				
Phosphorus EMC (mg/L)	0.26		Nitrogen EMC (mg/L)	1.86	Ì
Target Phosphorus Target Load (lb/acre/yr)	0.41		35 (9-)		
Pj	0.90				
Land Cover (acres)	A soils	B Soils	C Soils	D Soils	Totals
	A 30113	B dons	O GOIIS	D GOIIS	Totals
Forest/Open Space (acres) undisturbed,					
protected forest/open space or reforested land	0.00	0.00	0.00	0.00	0.00
Managed Turf (acres) disturbed, graded for yards or other turf to be mowed/managed	0.00	0.00	0.00	0.03	0.03
Impervious Cover (acres)	0.00	0.00	0.00	0.03	0.03
impervious cover (acres)	0.00	0.00	0.00	Total	0.14
				Total	0.17
Rv Coefficients					
	A soils	B Soils	C Soils	D Soils	
Forest/Open Space	0.02	0.03	0.04	0.05	
Managed Turf	0.15	0.20	0.22	0.25	
Impervious Cover	0.95	0.95	0.95	0.95	
Land Cover Summary					
Forest/Open Space Cover (acres)	0.00	ol .			
Weighted Rv(forest)	0.00				
% Forest	0%				
Managed Turf Cover (acres)	0.03				
Weighted Rv(turf)	0.25				
% Managed Turf	18%	b			
Impervious Cover (acres)	0.14	l.			
Rv(impervious)	0.95				
% Impervious	82%	5			
Total Site Area (acres)	0.17				
Site Rv	0.83	3			
Post-Development Treatment Volume (acre-ft)	0.01				
Post-Development Treatment Volume (cubic feet)	510				
Post_Development Load (TP) (lb/yr)	0.32		opment Load (TN) (lb/yr)	2.29	1
Total Load (TP) Reduction Required (lb/yr)	0.32		opinioni Load (IIV) (ID/yr)	2.29	



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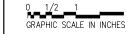
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ENGINEER:	M.M.	

SCALE:



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TITLE:

BMP CALCULATIONS

SHEET NUMBER: